

NOTES

1. THE IMAGERY SHOWN WAS PROVIDED BY AERIAL DATA SERVICES, 2016. ADDITIONAL IMAGERY SUPPLEMENTED FROM


USFWS-NWI AND USGS.

2. EXISTING FEATURES SHOWN WERE SURVEYED BY MOTT MACDONALD AND DIGITIZED FROM IMAGERY. ALL LOCATIONS ARE APPROXIMATE AND SHALL BE VERIFIED BY CONTRACTOR.

3. PROPERTY LINES DEPICTED ON THIS PLAN ARE BASED ON GIS TAX MAP DATA.

4. BASE FLOOD ELEVATION LINE SHOWN FOR 100 YEAR FLOOD PLAIN LIMIT WAS PULLED FROM FEMA FLOOD INSURANCE RATE MAPS (FIRM). THE ELEVATION OF 438 FEET WAS DETERMINED USING MAP NUMBERS 29189C0080K AND 17083C0278D.

SPIRE STL PIPELINE PROJECT REFERENCE DRAWINGS REFERENCE DRAWINGS REVISIONS **APPROVALS** HDD PROFILE OVERVIEW DWG. NO. TITLE DWG. NO. TITLE NO. REVISIONS DATE DRAWN CK APPR NO. REVISIONS DATE DRAWN CK APPR (MOTT M) D.R.G. 01/2017 D.G.G. 07/2017 01/2017 RJR EB RJP STLP-A-053 STLP-HDD-004 HDD PROFILE OVERVIEW ISSUE FOR FERC ALIGNMENT SHEET MISSISSIPPI RIVER MAINLINE 04/2017 RJR EB RJP 07/2017 RJR EB RJR STLP-AR-006 ACCESS ROAD SITE PLAN - PAR-018 AMENDMENT TO FERC STLP-HDD-003 MACDONALD ST. CHARLES COUNTY, MISSOURI M.A.P. 07/2017 J.E.W. 07/2017 FERC SUPPLEMENTAL FILING STLP-HDD-002

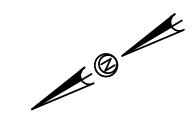



HDD NOTES:

- 1. ALL DIMENSIONS AND ELEVATIONS ARE IN FEET, UNLESS OTHERWISE SPECIFIED.
- 2. ALL CHAINAGES ARE HORIZONTAL.
- 3. CONTRACTOR SHALL DETERMINE FINAL LOCATIONS AND DIMENSIONS OF ALL PITS NECESSARY TO ACCOMMODATE THEIR MEANS AND METHODS.
- 4. CONTRACTOR SHALL DETERMINE DIAMETER, GRADE, WALL THICKNESS AND ADDITIONAL LENGTH OF TEMPORARY CONDUCTOR CASINGS THAN THOSE SHOWN ON THE DRAWINGS. ANY INSTALLED TEMPORARY CONDUCTOR CASING SHALL BE FULLY REMOVED UPON COMPLETION OF PULLBACK OPERATIONS.
- THE MINIMUM ALLOWABLE DRILLING RADIUS SHALL BE 1,750 FEET BASED ON A 3-JOINT AVERAGE.
- 6. EXISTING UTILITY LOCATIONS AND DEPTHS, INCLUDING PRIVATE SERVICES, ARE APPROXIMATE AND SHALL BE FIELD VERIFIED BY THE CONTRACTOR PRIOR TO ANY CONSTRUCTION OPERATIONS.
- 7. HDD OPERATIONS SHALL BE CONDUCTED IN ACCORDANCE WITH ALL PERMIT REQUIREMENTS.
- 8. DOWNHOLE ANNULAR DRILLING FLUID PRESSURES SHALL BE MONITORED AT ALL TIMES DURING THE PILOT BORE DRILLING PROCESS. LOCATION OF MONITORING SHALL BE AS CLOSE TO THE
- 9. PILOT BORE SHALL BE CONTINUOUSLY TRACKED AT ALL TIMES. NO BLIND SECTIONS SHALL BE PERMITTED, EVEN WHEN THE DRILL BIT IS UNDER WATER.
- 10. UPON HDD COMPLETION AND EXTRACTION OF TEMPORARY CASING PIPE (IF APPLICABLE), CONTRACTOR SHALL PLACE A UNIFORM CEMENT BASED GROUT WITHIN THE NEAREST 200 FEET OF THE ANNULAR SPACE OF THE HDD BORE BETWEEN THE PRODUCT PIPE AND THE UNDISTURBED EARTH AT EACH HDD ENTRY AND EXIT LOCATIONS. GROUT DELIVERY METHOD SHALL BE FROM MULTIPLE POINTS WITHIN THE ANNULAR SPACE. CONTRACTOR SHALL MONITOR AND CONTROL GROUT PRESSURES TO WITHIN LIMITS FOR THE ENCOUNTERED GEOTECHNICAL
- 11. IF THE CONTRACTOR ENCOUNTERS AN OBSTRUCTION THAT PREVENTS THE INSTALLATION ACCORDING TO THE PROJECT SPECIFICATIONS, THE CONTRACTOR SHALL PLACE A CEMENT BASED GROUT WITHIN THE BORE. WORK SHALL NOT RESUME UNTIL REVISED PLANS AND PROCEDURES HAVE BEEN SUBMITTED TO AND ACCEPTED BY THE OWNER.
- 12. CONTRACTOR SHALL USE THE DRILL AND INTERSECT INSTALLATION STRATEGY TO COMPLETE THIS INSTALLATION.
- 13. THE PILOT BORE WILL BE EITHER 10.625" OR 12.25" IN DIAMETER. THE FINAL REAMED HOLE DIAMETER IS ANTICIPATED TO BE 36". THE NUMBER OF REAMING PASSES WILL BE DETERMINED BY THE
- 14. CONTRACTOR SHALL USE A GYROSCOPIC GUIDANCE SYSTEM TO COMPLETE THE PILOT BORE INSTALLATION.

CONTRACTOR SELECTED FOR THE WORK.


15. CONTRACTOR SHALL MONITOR PRECIPITATION AND RIVER LEVEL ELEVATIONS AND BE PREPARED TO REMOVE EQUIPMENT PRIOR TO A FORECASTED FLOOD EVENT


MISSOURI RIVER HDD PLAN VIEW


Rock Stratagraphic Legend:

LIMESTONE

CONCRETE

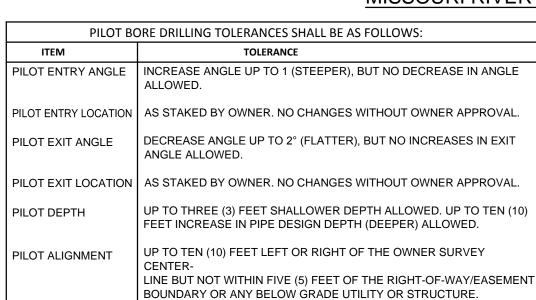

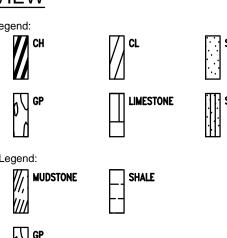

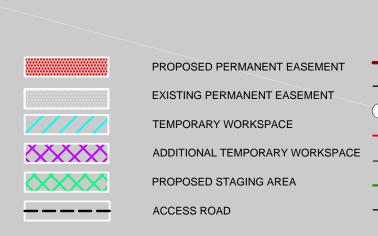

USACE EASEMENT


LEGEND PROPOSED 24-INCH DIAMETER STREAM (DELINEATED) PROPERTY LINE STREAM (DESKTOP) X X X X-.0000 MMID WETLAND (DESKTOP) EXISTING GAS PIPELINE WETLAND (DELINEATED) ——— EXISTING FOREIGN PIPELINE ——— OH——— EXISTING OVERHEAD LINE ——— ROAD CENTERLINE


THE IMAGERY SHOWN WAS PROVIDED BY AERIAL DATA SERVICES, 2016. ADDITIONAL IMAGERY SUPPLEMENTED FROM

EXISTING FEATURES SHOWN WERE SURVEYED BY MOTT MACDONALD AND DIGITIZED FROM IMAGERY. ALL LOCATIONS ARE APPROXIMATE AND SHALL BE VERIFIED BY CONTRACTOR. PROPERTY LINES DEPICTED ON THIS PLAN ARE BASED ON GIS TAX MAP DATA.

BASE FLOOD ELEVATION LINE SHOWN FOR 100 YEAR FLOOD PLAIN LIMIT WAS PULLED FROM FEMA FLOOD INSURANCE

RATE MAPS (F	RATE MAPS (FIRM). THE ELEVATION OF 438 FEET WAS DETERMINED USING MAP NUMBERS 29189C0080K AND 17083C0278D.																					
REFERENCE DRAWINGS		REFERENCE DRAWINGS		REVISIONS				REVISIONS				APPROVALS							PREPARED BY	SPIRE STL PIPELINE PROJECT		
DWG. NO.	TITLE	DWG. NO.	TITLE	NO.	REVISIONS	DATE DRAW	N CK	. AF	NPPR NC	IO. REVISIONS	DATE DRAV	WN CK	APPR	DRAWN BY	DATE	ENG. APPROVAL	DATE	CLIENT APPROVAL	DATE	Spire M	M	HDD PROFILE OVERVIEW
STLP-A-066	ALIGNMENT SHEET			3	FERC SUPPLEMENTAL FILING	07/2017 RJP	EB	R	RJP					R.J.P.	07/2017	D.G.G.	07/2017				I M	MISSOURI RIVER MAINI INF
STLP-A-067	ALIGNMENT SHEET													CHECKED BY	DATE	P.M. APPROVAL	DATE	STLP-HDD-005A	Δ.	STL Pipeline	MOTT MACDONALD	WIGOODKI KIVEK WAINLINE
														M.A.P.	07/2017	J.E.W.	07/2017		A			ST. CHARLES & ST. LOUIS COUNTIES, MISSOURI

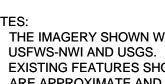

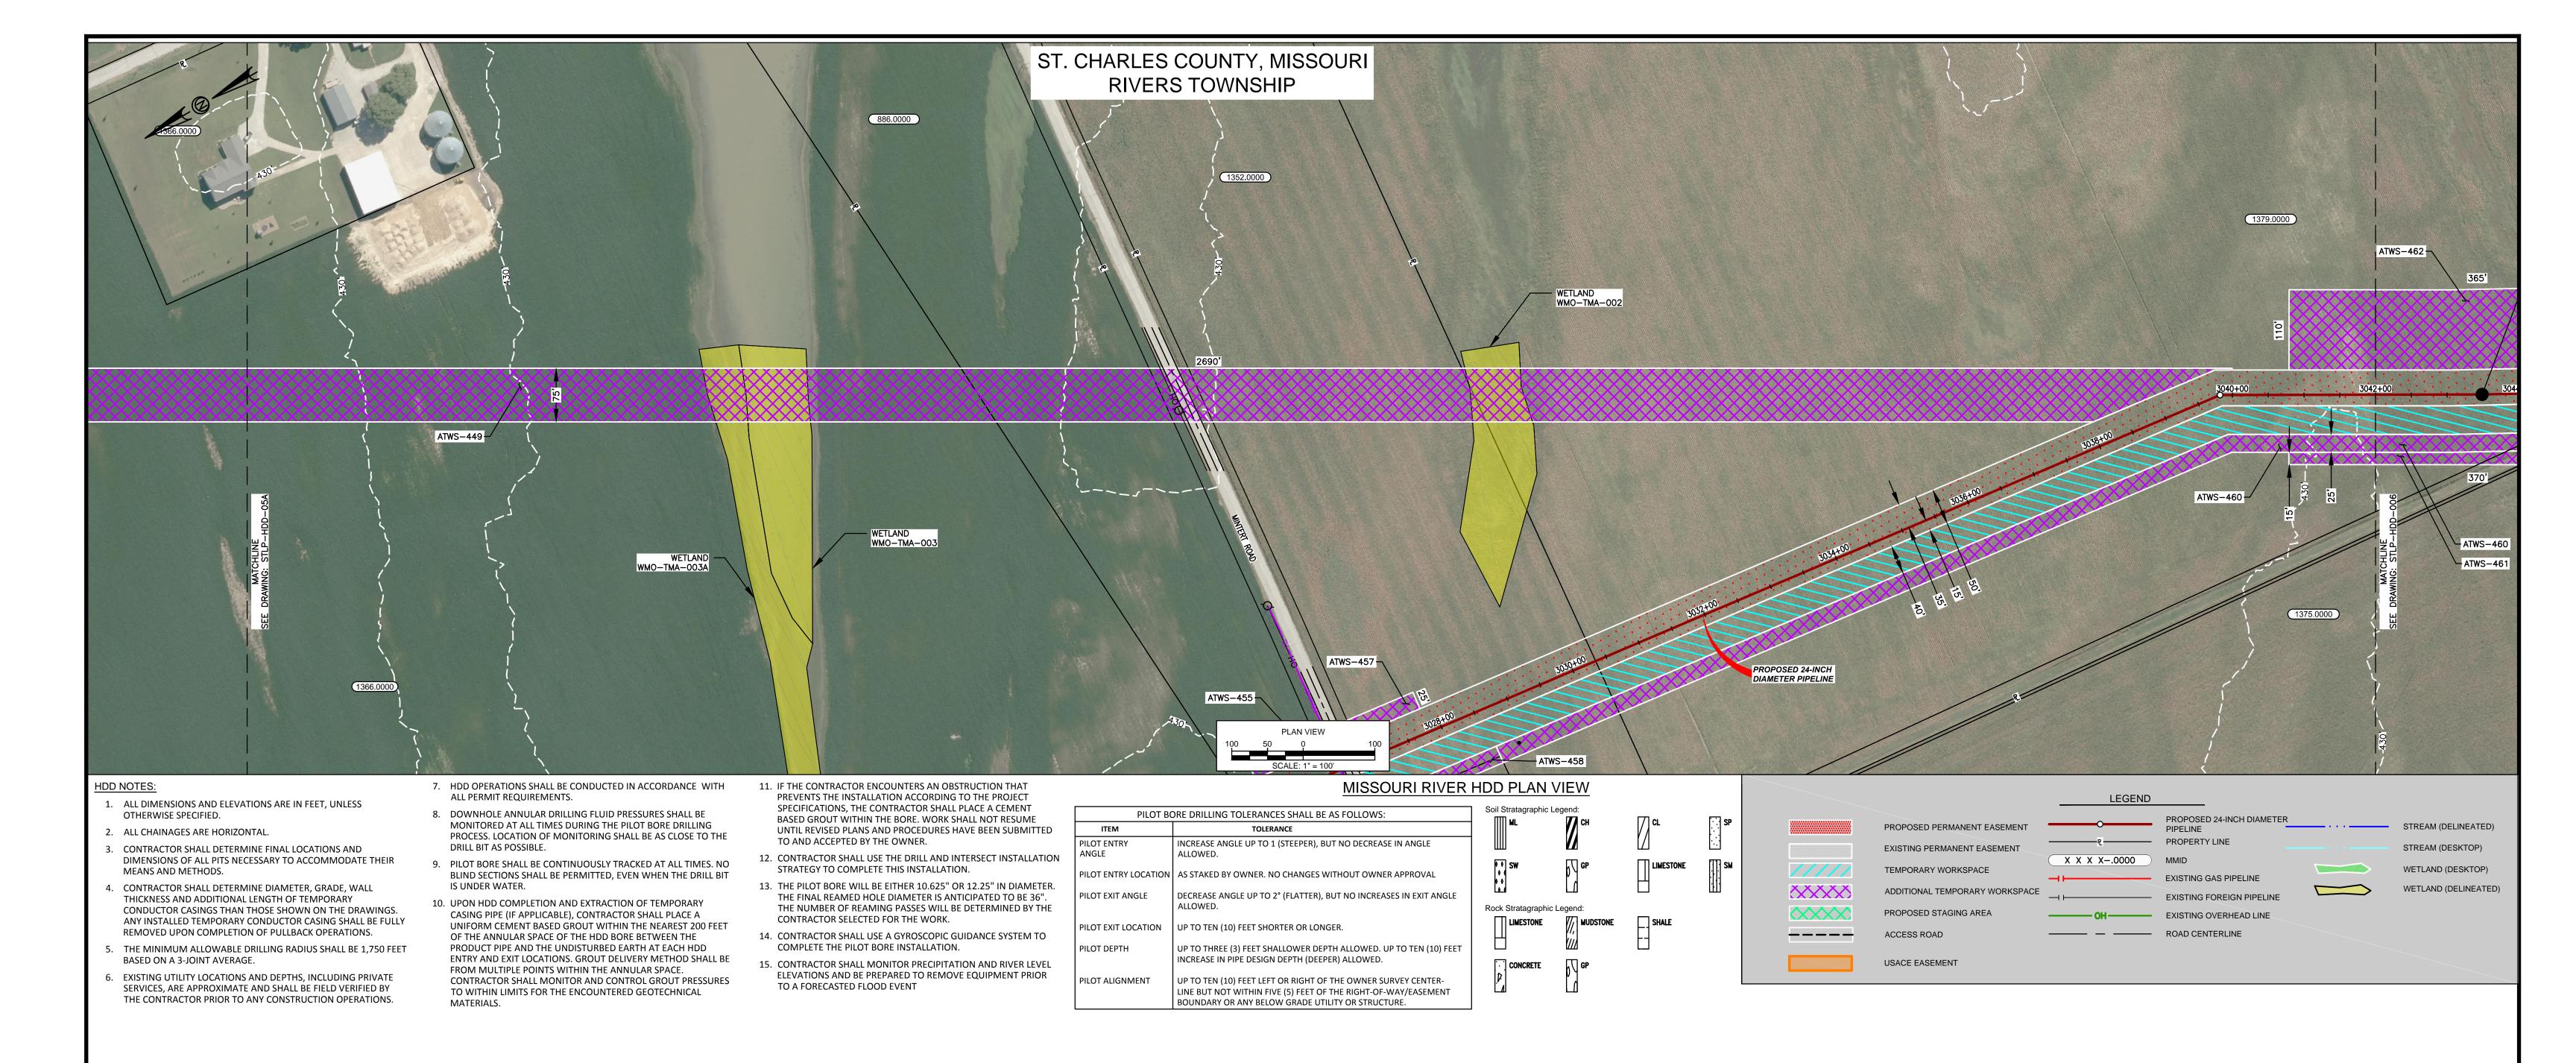

OTES:


THE IMAGERY SHOWN WAS PROVIDED BY AERIAL DATA SERVICES, 2016. ADDITIONAL IMAGERY SUPPLEMENTED FROM USFWS-NWI AND USGS.


EXISTING FEATURES SHOWN WERE SURVEYED BY MOTT MACDONALD AND DIGITIZED FROM IMAGERY. ALL LOCATIONS ARE APPROXIMATE AND SHALL BE VERIFIED BY CONTRACTOR.


PROPERTY LINES DEPICTED ON THIS PLAN ARE BASED ON GIS TAX MAP DATA.
 BASE FLOOD ELEVATION LINE SHOWN FOR 100 YEAR FLOOD PLAIN LIMIT WAS PI

BASE FLOOD ELEVATION LINE SHOWN FOR 100 YEAR FLOOD PLAIN LIMIT WAS PULLED FROM FEMA FLOOD INSURANCE RATE MAPS (FIRM). THE ELEVATION OF 438 FEET WAS DETERMINED USING MAP NUMBERS 29189C0080K AND 17083C0278D.

SPIRE STL PIPELINE PROJECT REFERENCE DRAWINGS REVISIONS **APPROVALS** HDD PROFILE OVERVIEW DWG. NO. TITLE DWG. NO. TITLE NO. REVISIONS DATE DRAWN CK APPR NO. REVISIONS DATE DRAWN CK APPR I MOTT M 1 R.J.P. 07/2017 D.G.G. 07/2017 01/2017 RJR EB RJP STLP-A-066 ISSUE FOR FERC ALIGNMENT SHEET MISSOURI RIVER MAINLINE 04/2017 RJR EB RJP 07/2017 RJR EB RJP STLP-A-067 ALIGNMENT SHEET HDD PROFILE OVERVIEW STLP-HDD-005 MACDONALD ST. CHARLES & ST. LOUIS COUNTIES, MISSOURI M.A.P. 07/2017 J.E.W. 07/2017 FERC SUPPLEMENTAL FILING

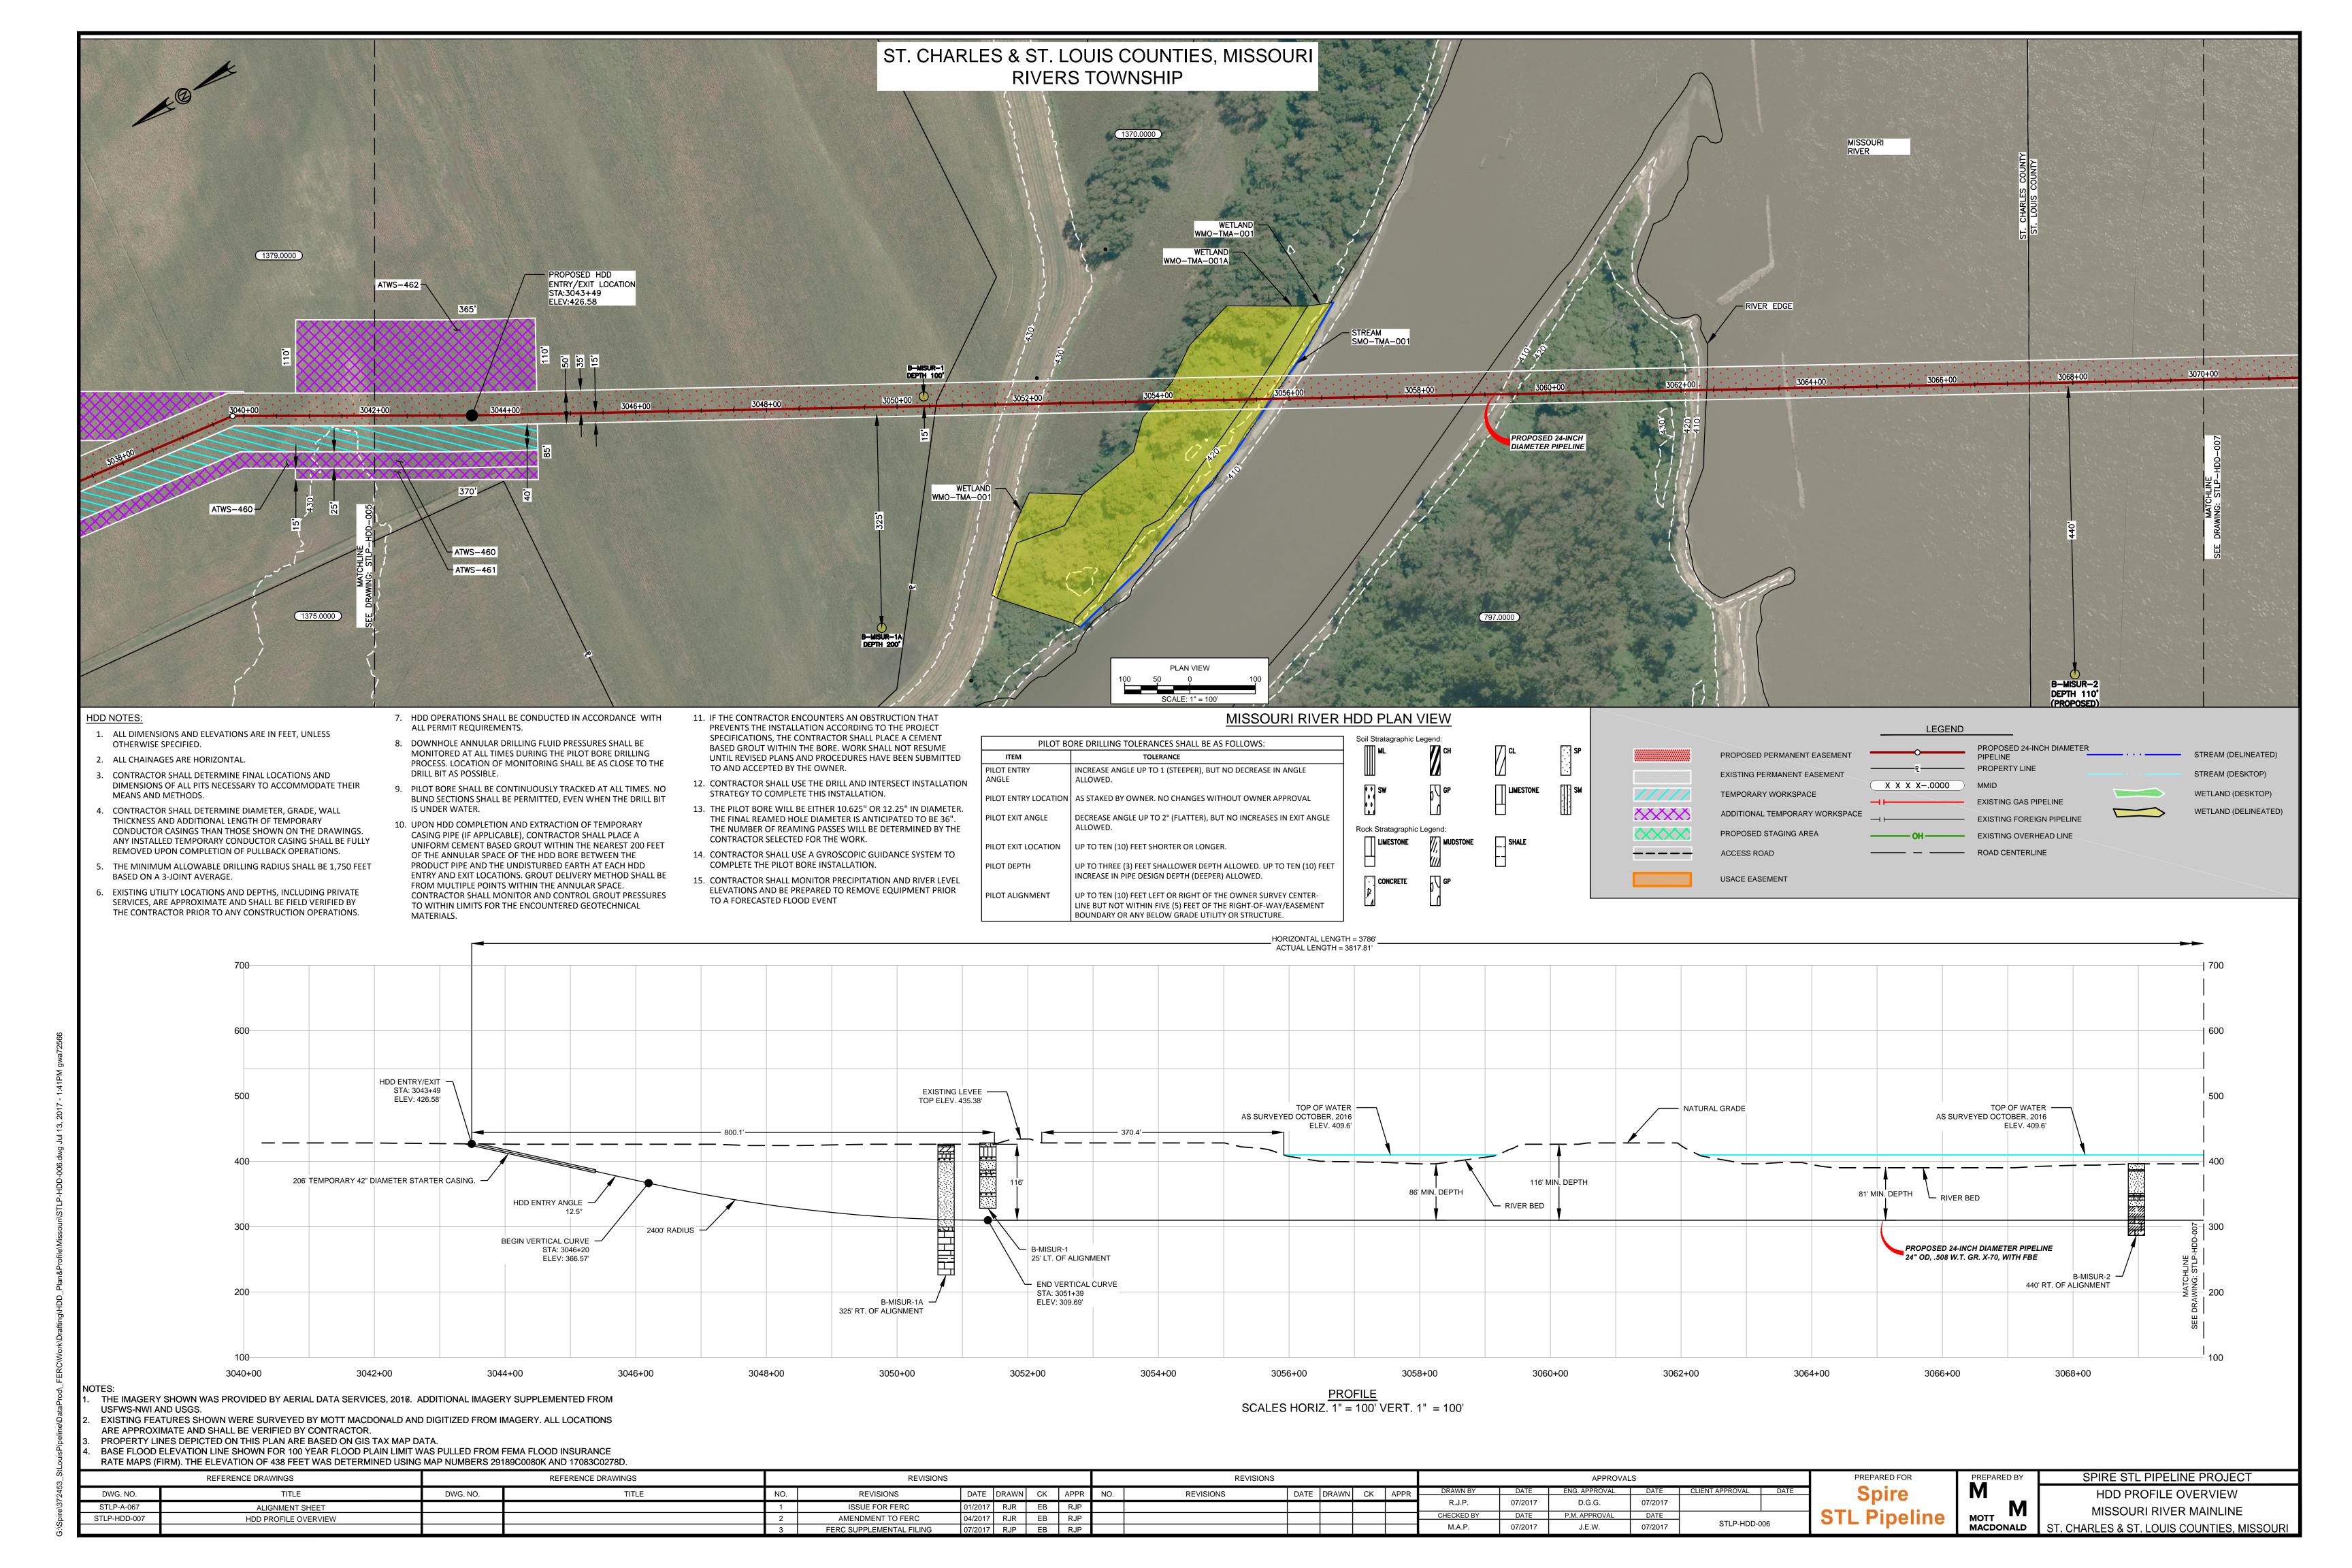

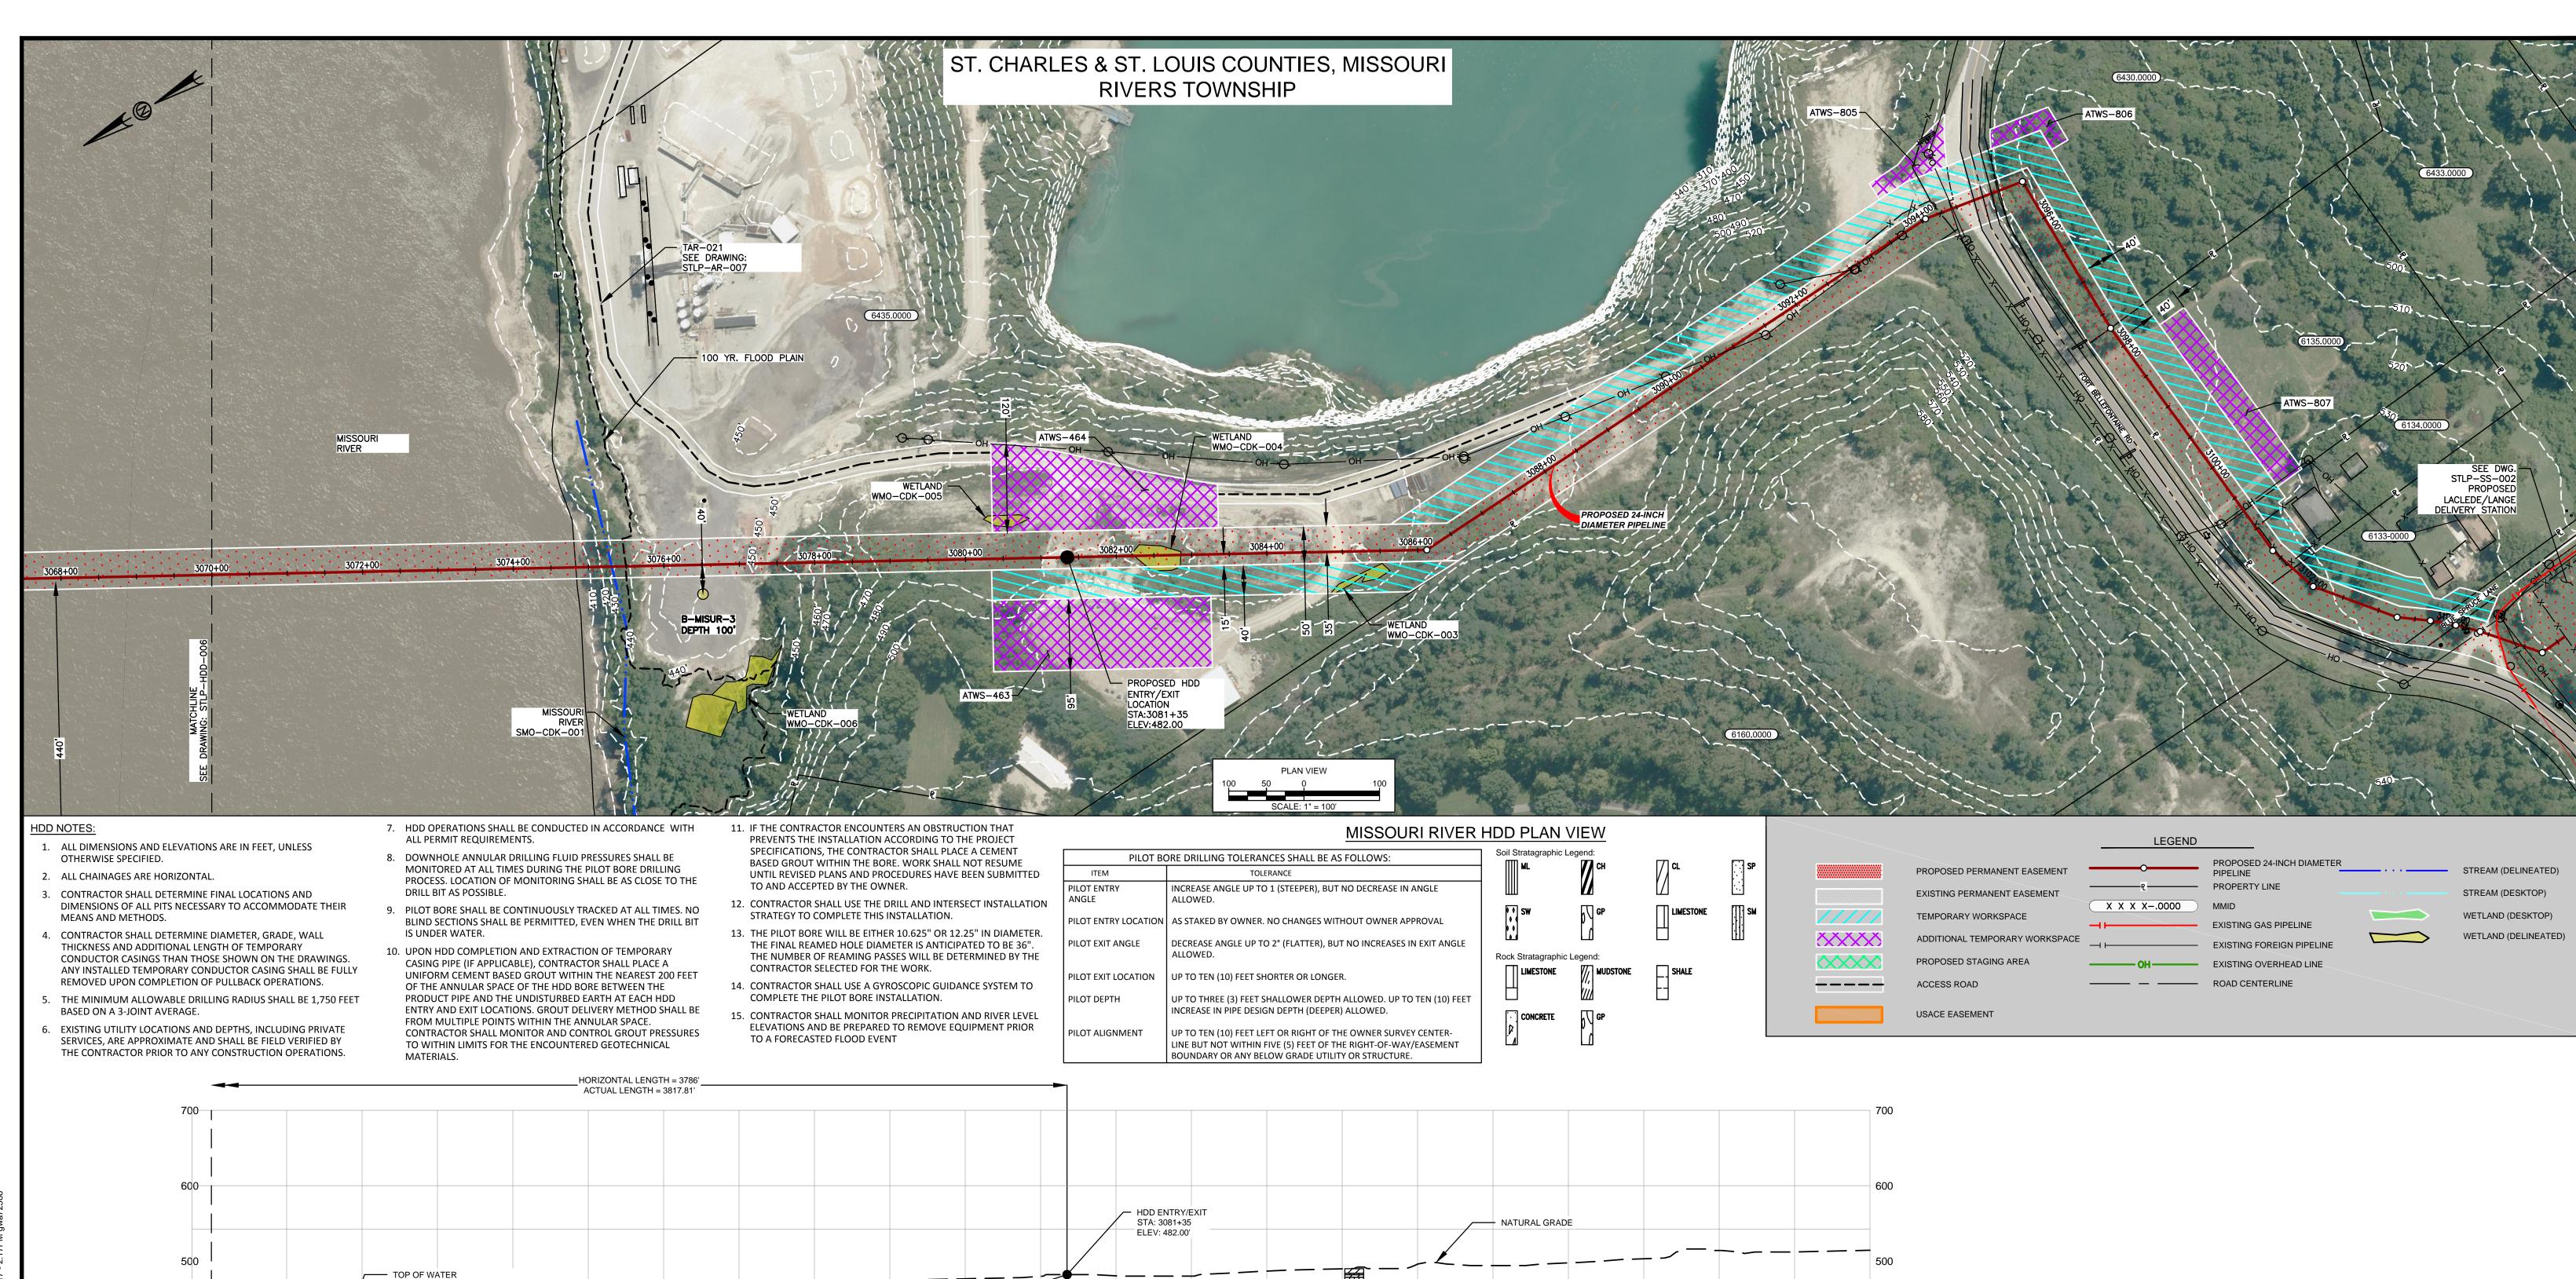

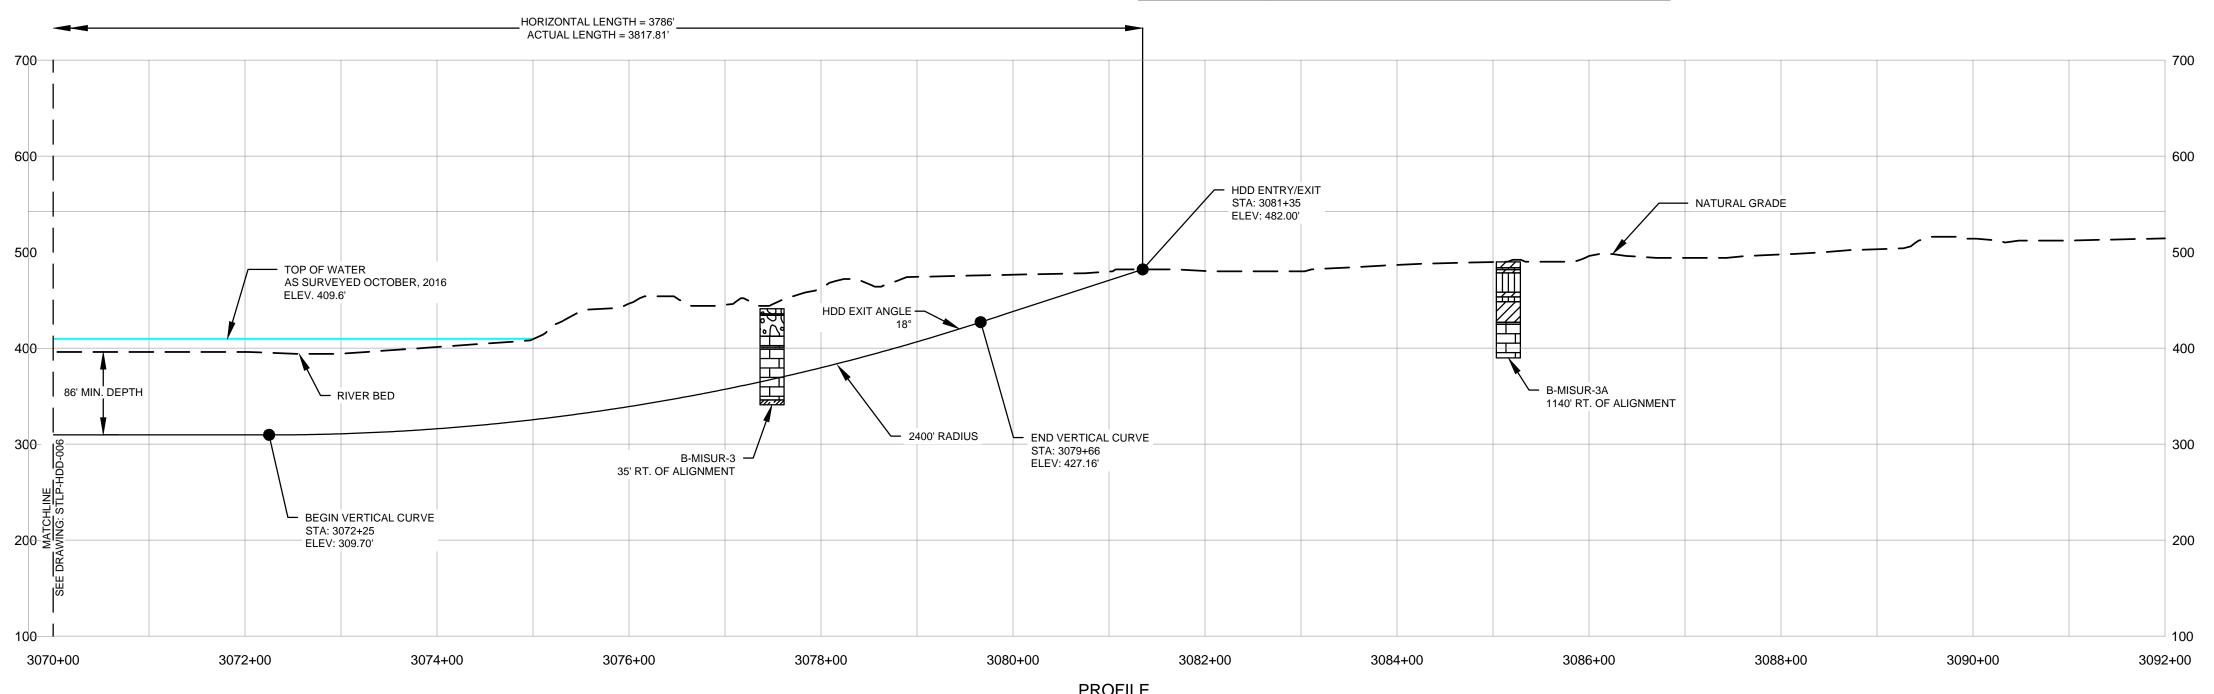

SCALES HORIZ. 1" = 100' VERT. 1" = 100'

. THE IMAGERY SHOWN WAS PROVIDED BY AERIAL DATA SERVICES, 2016. ADDITIONAL IMAGERY SUPPLEMENTED FROM USFWS-NWI AND USGS.


2. EXISTING FEATURES SHOWN WERE SURVEYED BY MOTT MACDONALD AND DIGITIZED FROM IMAGERY. ALL LOCATIONS ARE APPROXIMATE AND SHALL BE VERIFIED BY CONTRACTOR.

3. PROPERTY LINES DEPICTED ON THIS PLAN ARE BASED ON GIS TAX MAP DATA. 4. BASE FLOOD ELEVATION LINE SHOWN FOR 100 YEAR FLOOD PLAIN LIMIT WAS PULLED FROM FEMA FLOOD INSURANCE

RATE MAPS (FIRM). THE ELEVATION OF 438 FEET WAS DETERMINED USING MAP NUMBERS 29189C0080K AND 17083C0278D.

SPIRE STL PIPELINE PROJECT REFERENCE DRAWINGS REFERENCE DRAWINGS REVISIONS **APPROVALS** HDD PROFILE OVERVIEW REVISIONS DATE DRAWN CK APPR REVISIONS DATE DRAWN CK APPR DWG. NO. TITLE DWG. NO. TITLE R.J.P. 07/2017 D.G.G. 07/2017 1/2017 RJR EB RJP STLP-A-068 STLP-HDD-006 HDD PROFILE OVERVIEW ALIGNMENT SHEET ISSUE FOR FERC MISSOURI RIVER MAINLINE 04/2017 RJR EB RJP 07/2017 RJP EB RJP STLP-AR-007 ACCESS ROAD SITE PLAN - TAR-021 AMENDMENT TO FERC STLP-HDD-007 MACDONALD ST. CHARLES & ST. LOUIS COUNTIES, MISSOURI 07/2017 07/2017 LACLEDE/LANGE DELIVERY STATION SITE LAYOUT - STLP-SS-002 FERC SUPPLEMENTAL FILING

stLouisPipeline∖DataProd\ FERC\Work\Drafting\HDD_Plan&Profile\Missourì\STLP-HDD-007.dwg Jul

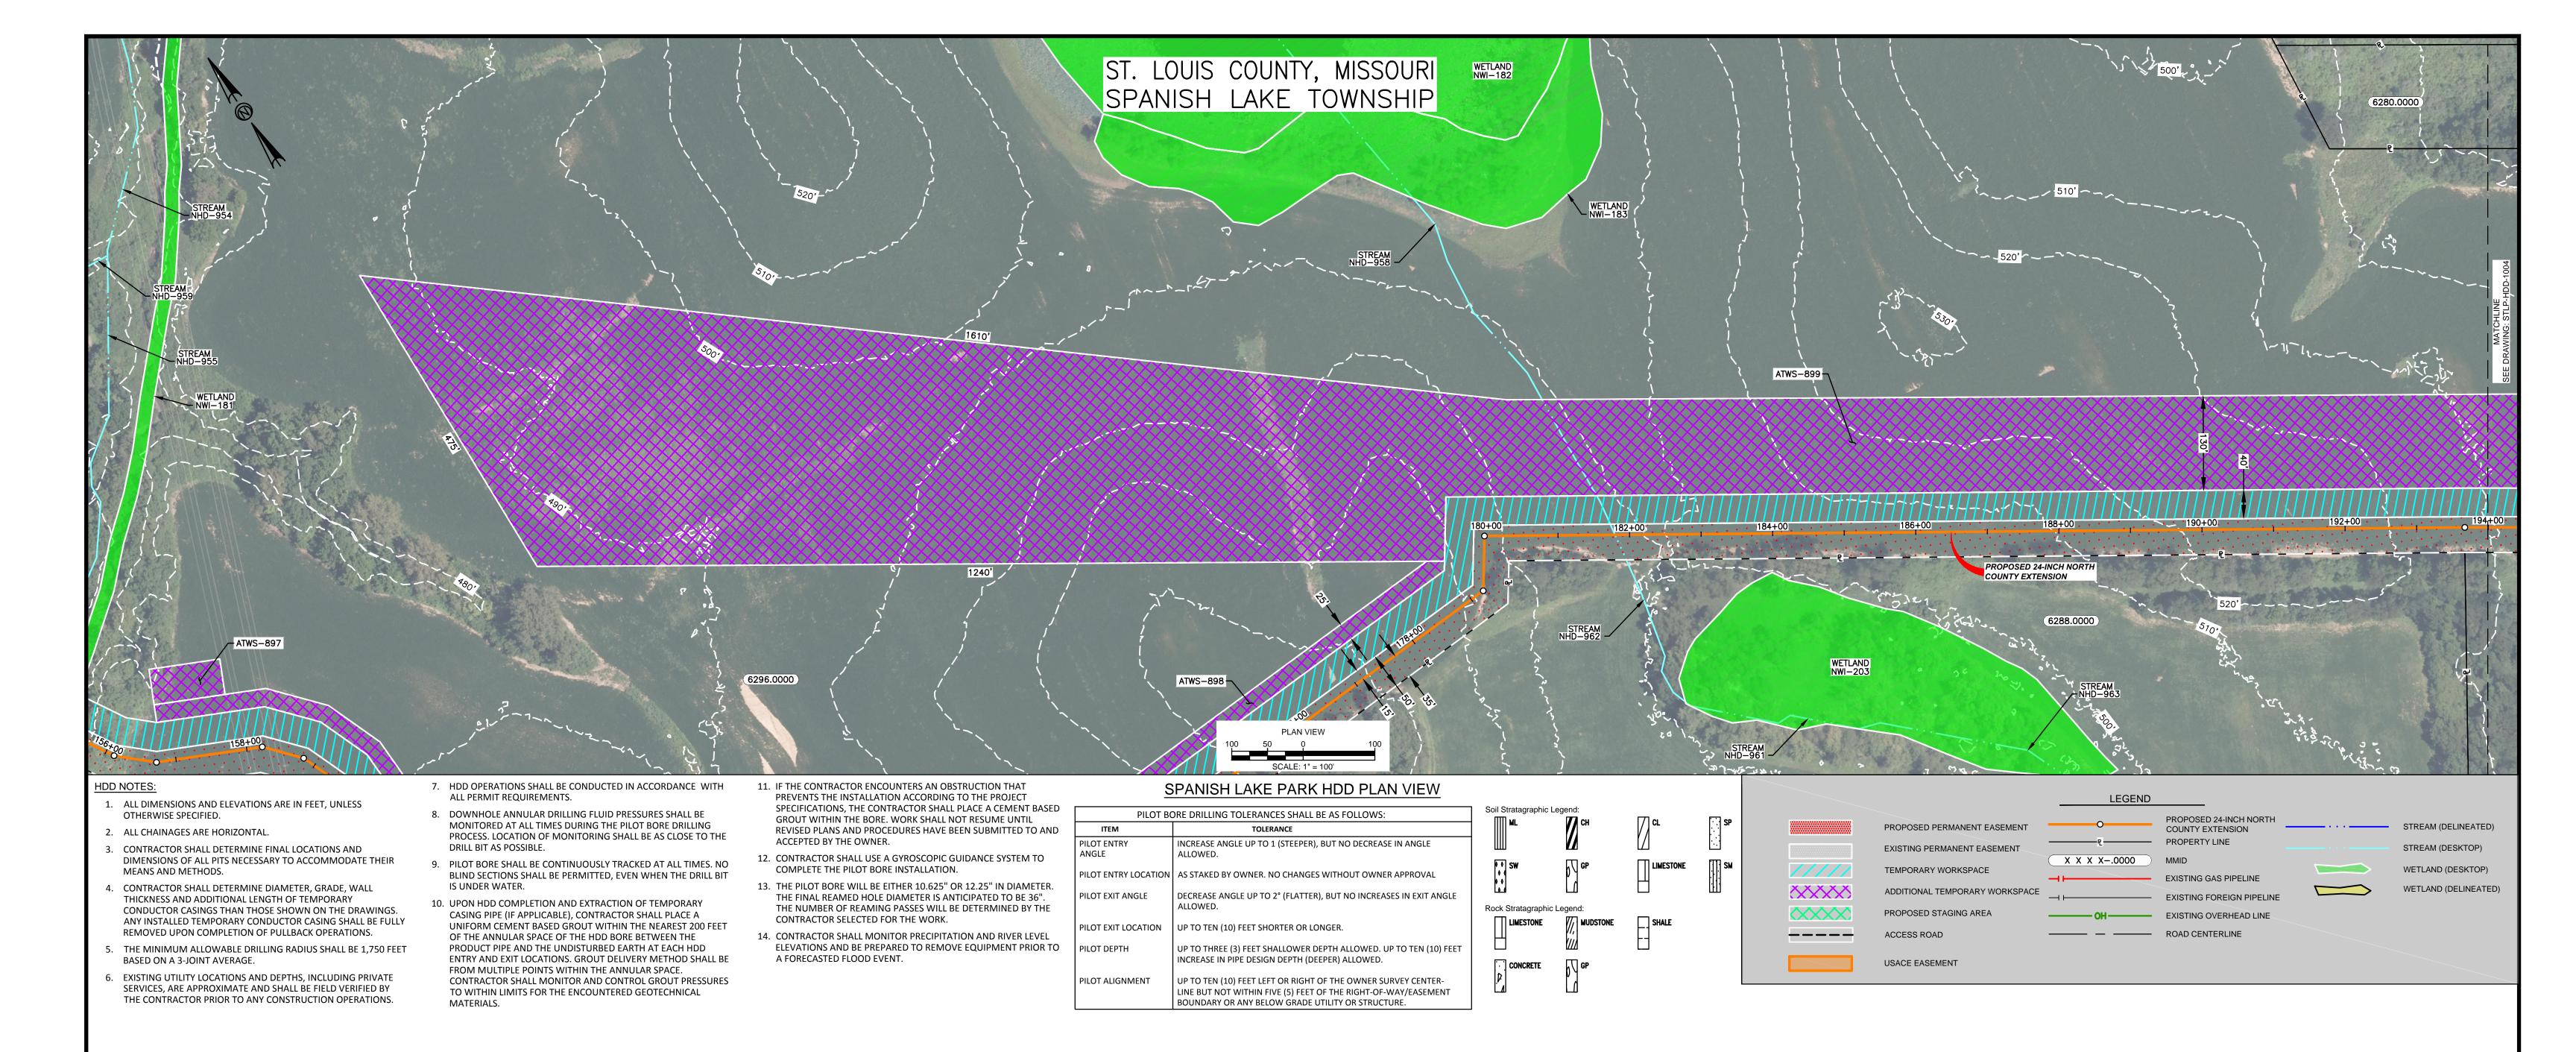

THE IMAGERY SHOWN WAS PROVIDED BY AERIAL DATA SERVICES, 2017. ADDITIONAL IMAGERY SUPPLEMENTED FROM

USFWS-NWI AND USGS.
2. EXISTING FEATURES SHOWN WERE SURVEYED BY MOTT MACDONALD AND DIGITIZED FROM IMAGERY. ALL LOCATIONS ARE APPROXIMATE AND SHALL BE VERIFIED BY CONTRACTOR.

3. PROPERTY LINES DEPICTED ON THIS PLAN ARE BASED ON GIS TAX MAP DATA.

BASE FLOOD ELEVATION LINE SHOWN FOR 100 YEAR FLOOD PLAIN LIMIT WAS PULLED FROM FEMA FLOOD INSURANCE RATE MAPS (FIRM). THE ELEVATION OF 438 FEET WAS DETERMINED USING MAP NUMBERS 29189C0080K AND 17083C0278D.

SPIRE STL PIPELINE PROJECT REFERENCE DRAWINGS **APPROVALS** HDD PROFILE OVERVIEW TITLE DWG. NO. TITLE REVISIONS DATE DRAWN CK APPR REVISIONS DATE DRAWN CK APPR DWG. NO. MOTT SPANISH LAKE PARK NORTH COUNTY EXTENSION R.J.P. 07/2017 D.G.G. 07/2017 04/2017 AK KAM RJP STLP-A-1004 AMENDMENT TO FERC ALIGNMENT SHEET FERC SUPPLEMENTAL FILING 07/2017 RJP KAM RJP STLP-HDD-1004 HDD PROFILE OVERVIEW STLP-HDD-1003 MACDONALD SPANISH LAKE TOWNSHIPS, ST. LOUIS, MISSOURI M.A.P. 07/2017 J.E.W. 07/2017

